




01 Storm Drainage Sect 1  
117 SCALE 1:1000

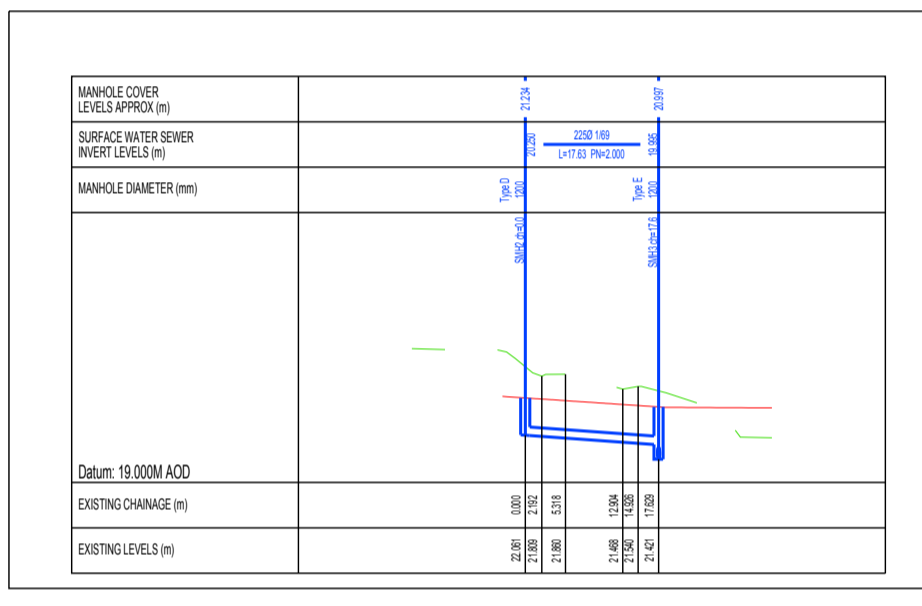


02 Storm Drainage Long Sect  
117 SCALE 1:1000

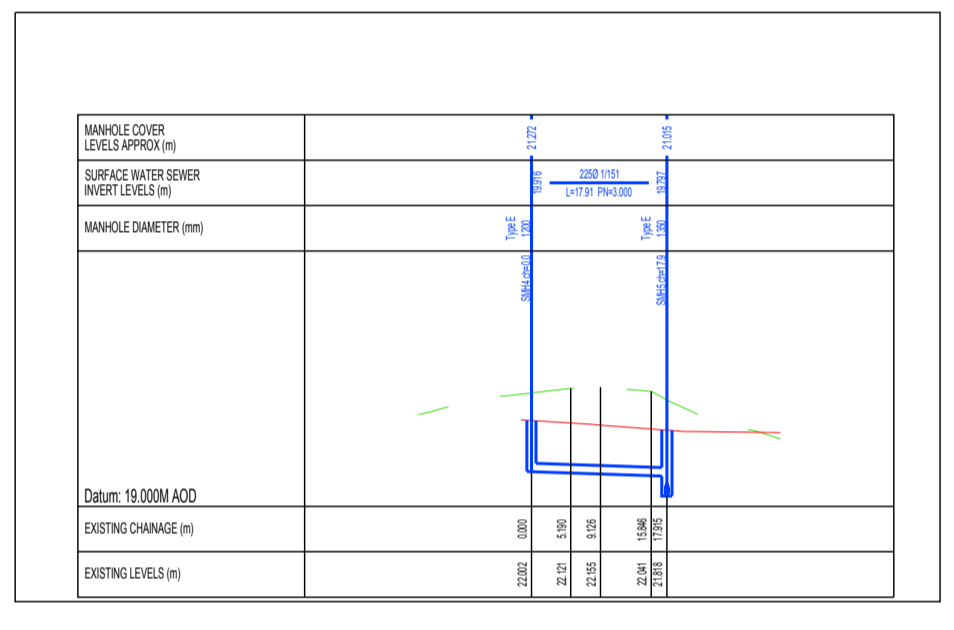


03 Storm Drainage Long Sect  
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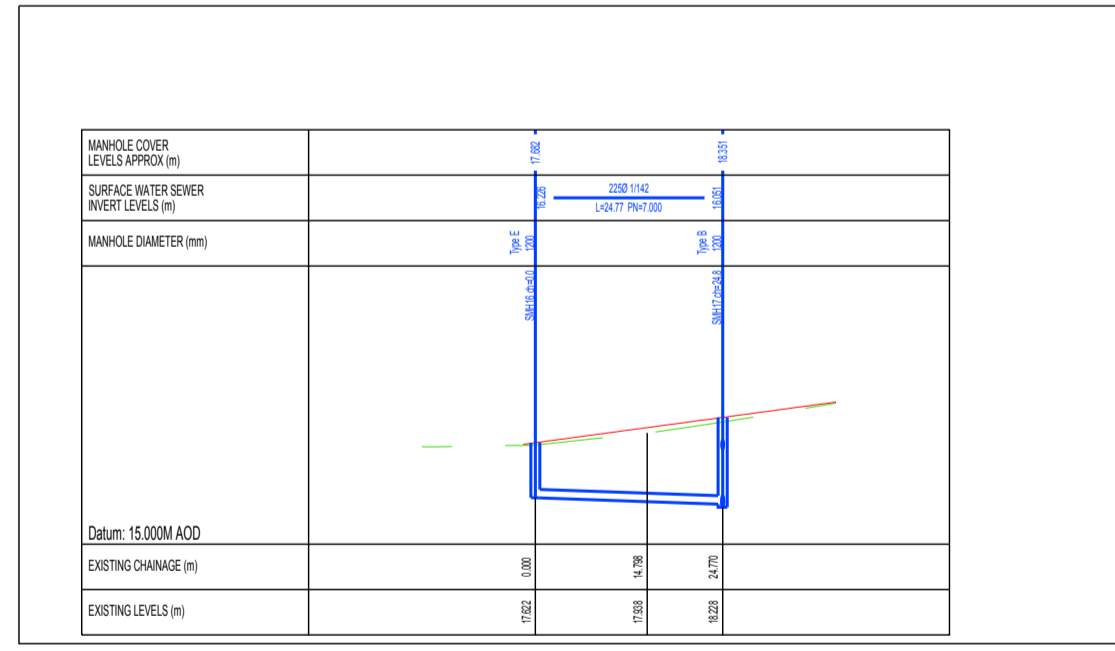
04 Storm Drainage Long Sect  
117 SCALE 1:1000

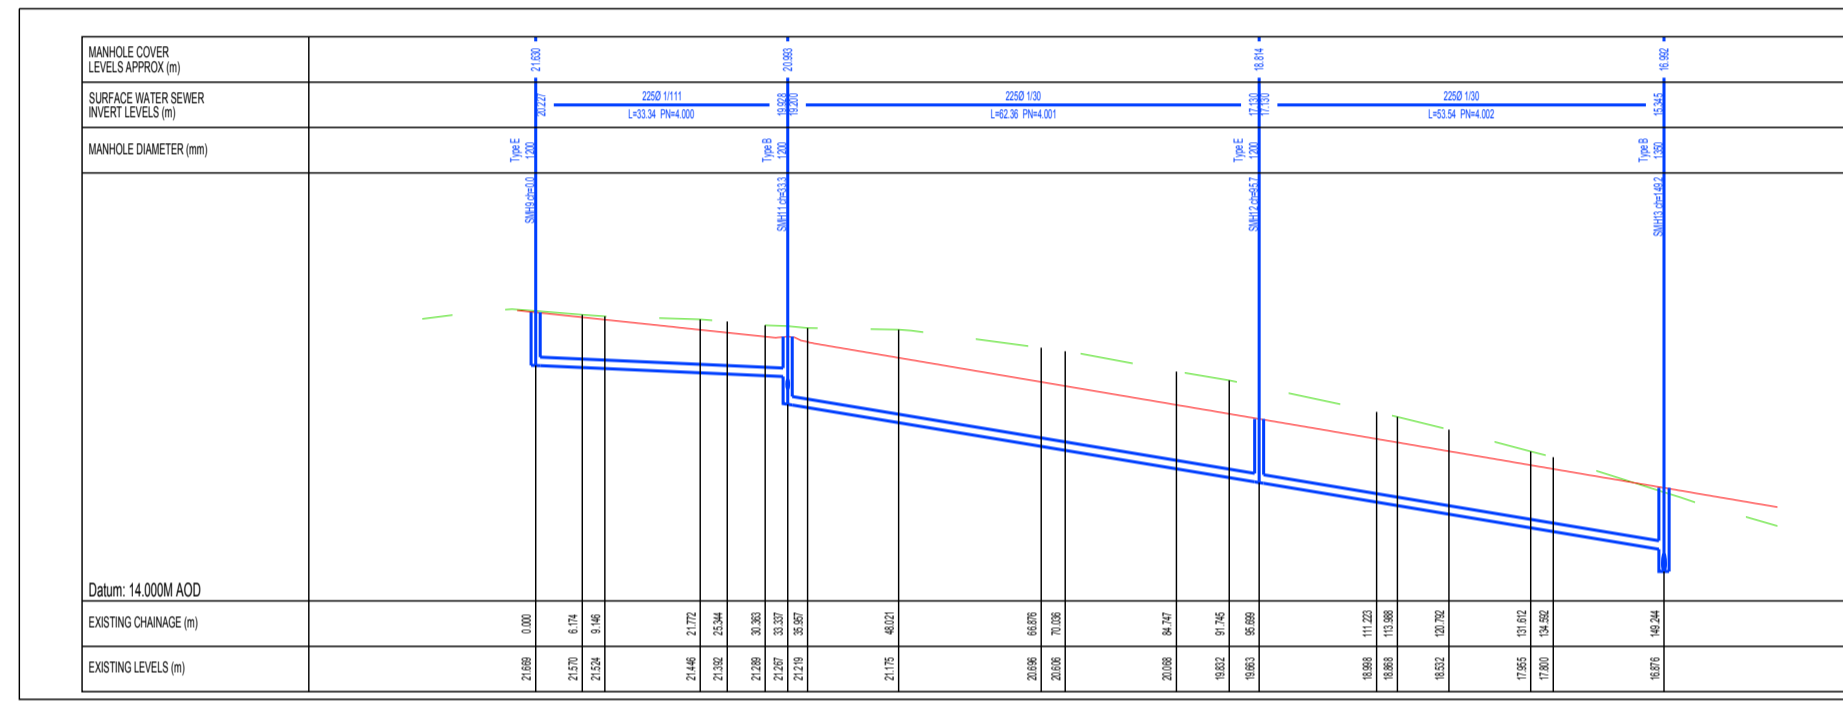


05 Storm Drainage Long Sect  
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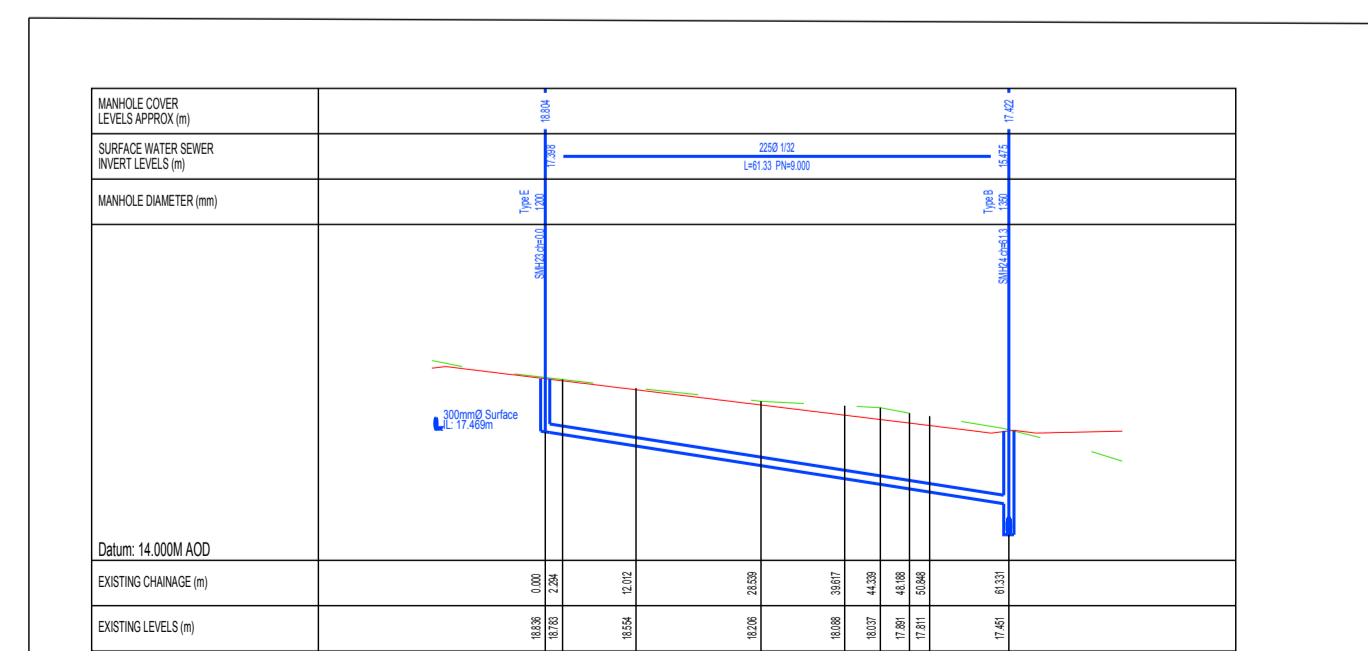
06 Storm Drainage Long Sect  
117 SCALE 1:1000

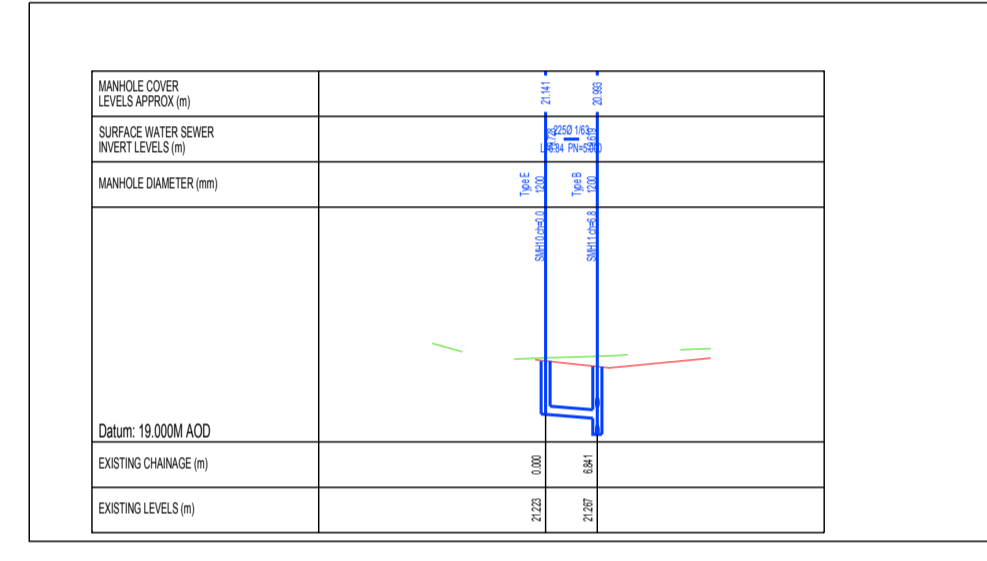


07 Storm Drainage Long Sect  
117 SCALE 1:1000

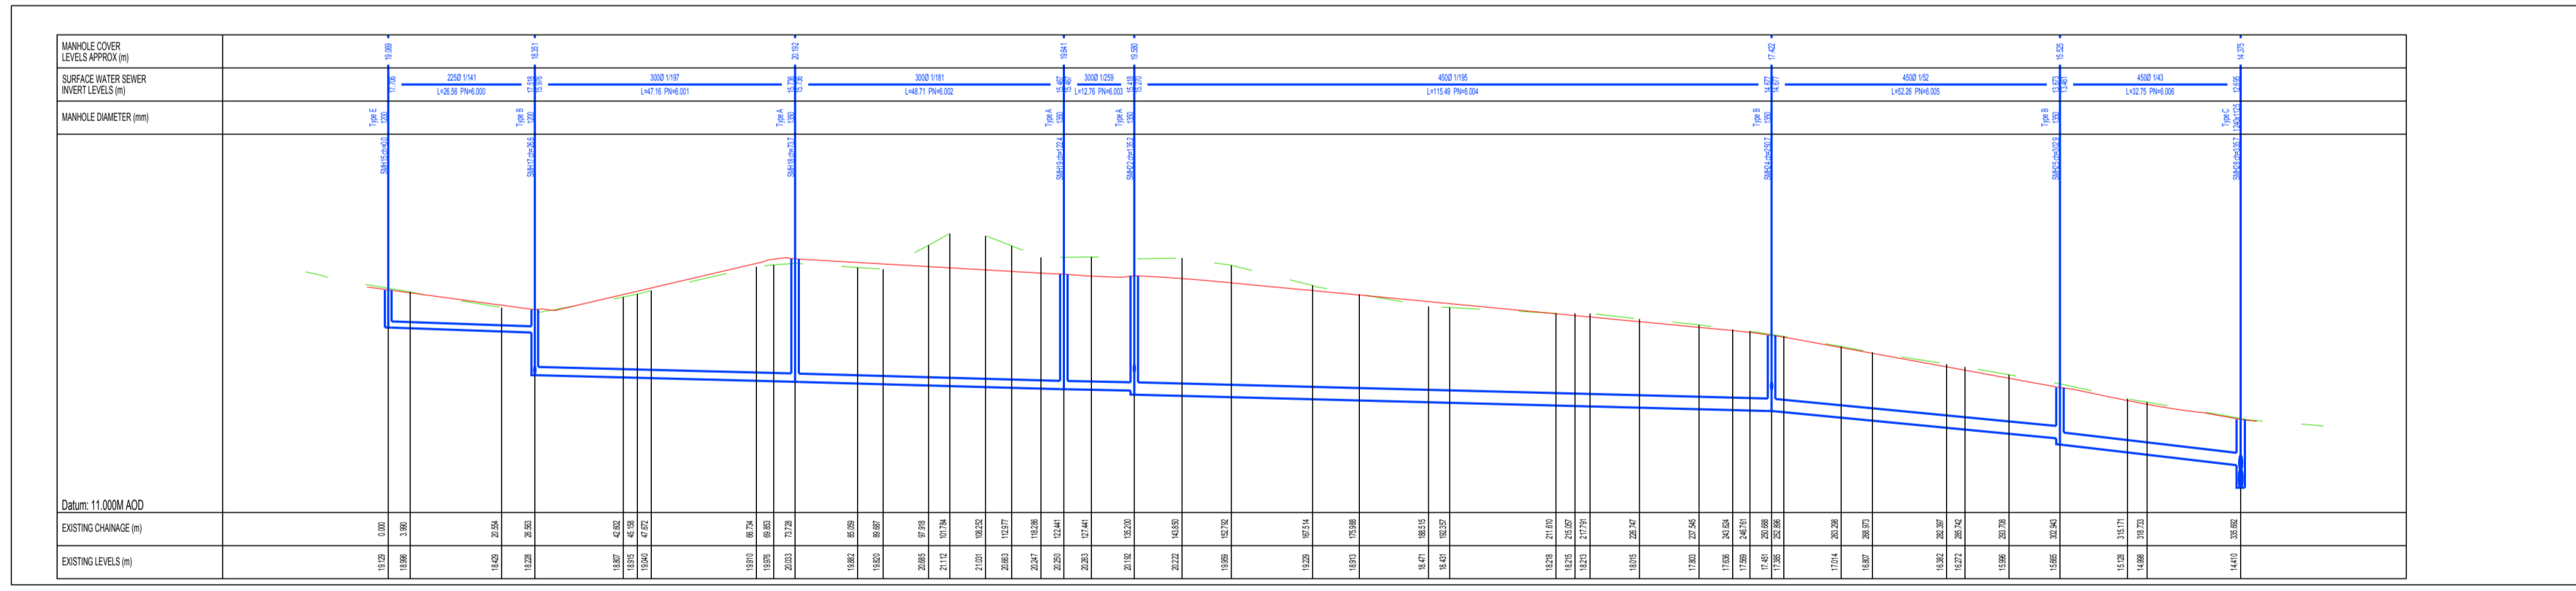

08 Storm Drainage Long Sect  
117 SCALE 1:1000

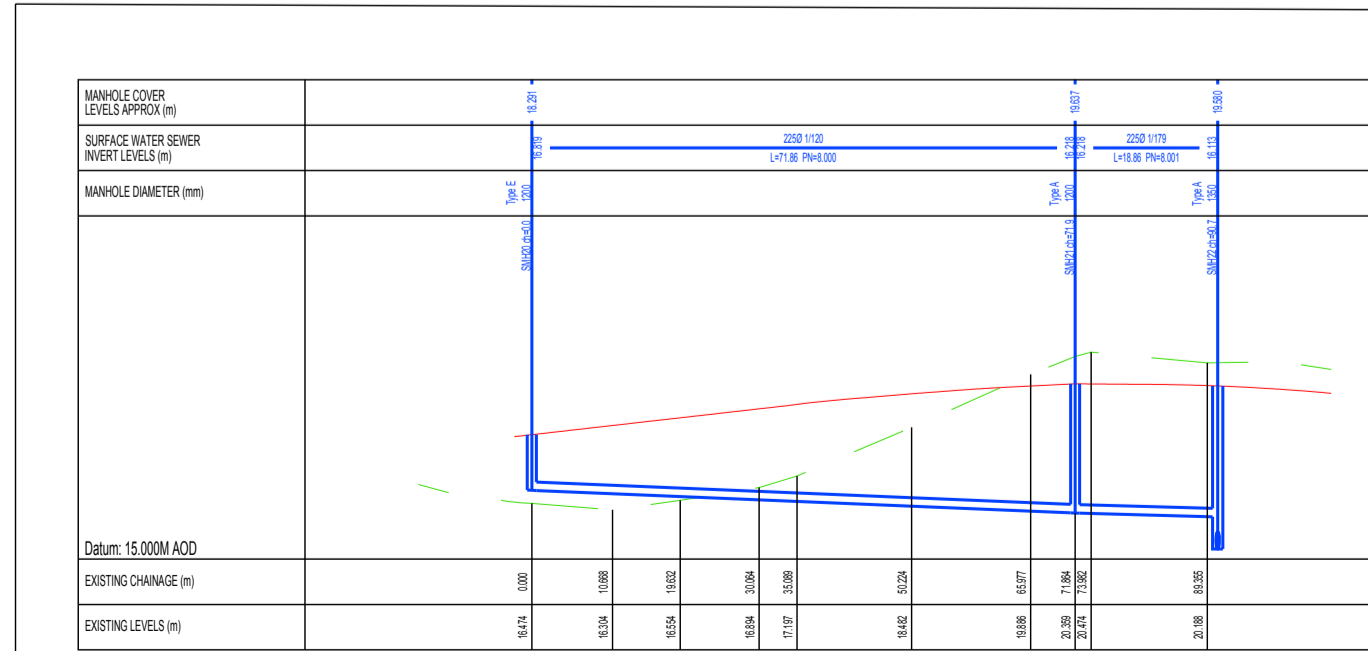

09 Storm Drainage Long Sect  
117 SCALE 1:1000

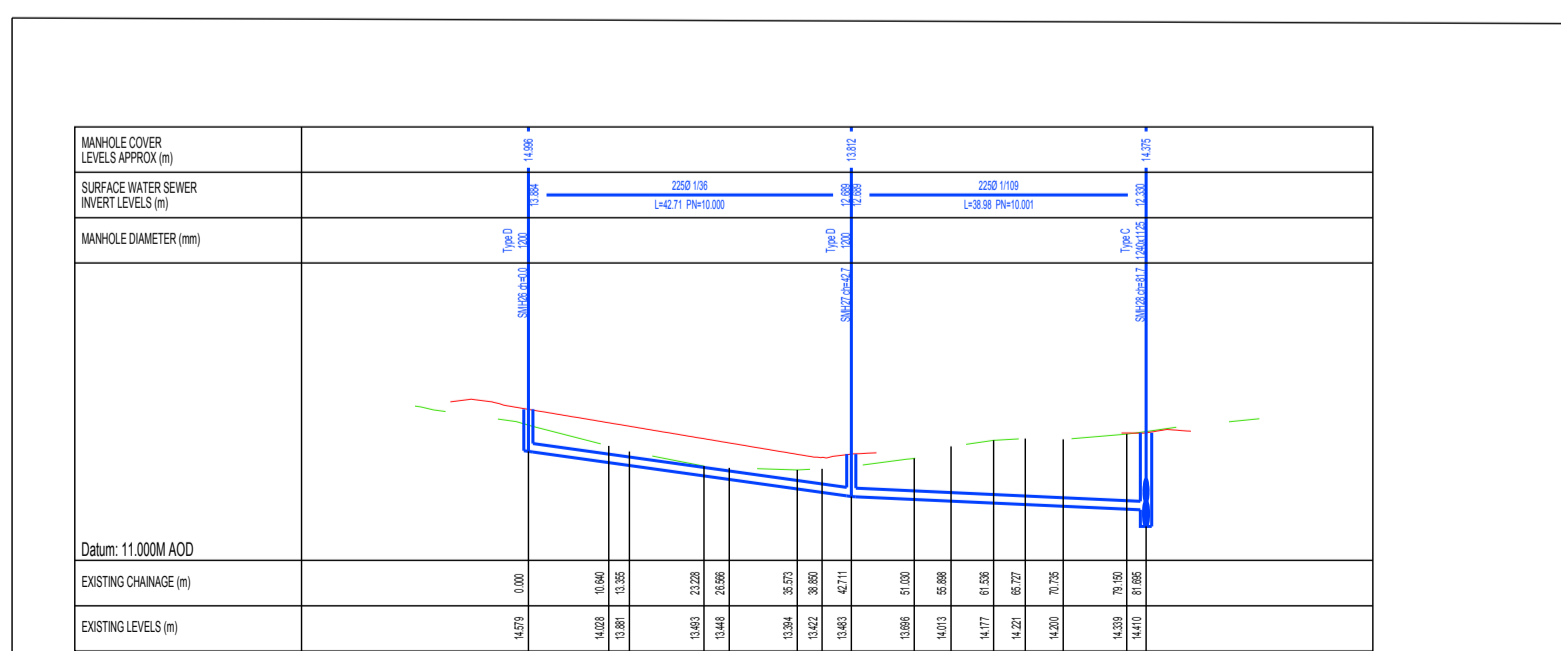

10 Storm Drainage Long Sect  
117 SCALE 1:1000

REV. NO.	DESCRIPTION	DATE	INITIALS
A	Issued for Planning	May 2019	T. Finn

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DESIGN PARTNERSHIP  
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DRAWING NO: **117** REV. NO: **A**

TITLE: Storm Drainage  
Longitudinal Sections (Sheet 1 of 3)

PROJECT: Residential Development @  
Haggardstown, Blackrock, Dundak

CLIENT: Kingsbridge Consultancy Ltd  
1st Floor Quayside Business Park  
Mill Street, Dundak, Co Louth.

SCALE: 1:1000 @ A1 DRAWN: A. Armstrong

DATE: November 2018 CHECKED: -

STATUS: **Planning Permission**

JOB NO: **1703**

**ENG**

NOTES:  
1. Copyright Reserved 2003 ©  
2. Work to fit grid dimensions only. Do not scale drawing.  
3. The contractor is responsible for checking all levels and dimensions on site and shall refer all discrepancies to the Architect.  
4. Where appropriate, for details of c. structure or mechanical and electrical details, see Engineers drawings.  
5. Proprietary items shall be fixed in place in accordance with manufacturers instructions.  
6. Costs of proprietary items shall be checked with manufacturers.  
7. The contractor shall be responsible for the coordination of structure, finishes and services.  
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